


NOTE:

The Contractor is to check and verify all building and site dimensions, levels and sewer invert levels at connection points before work starts. This drawing must be read with and checked against any structural or other specialist drawings provided. The Contractor is to comply in all respects with the current Building Regulations whether or not specifically stated on these drawings. This drawing is not intended to show details of foundation or ground conditions. Each area of ground relied upon to support the structure depicted must be investigated by the Contractor and suitable methods of foundation be provided.



PROPOSED REAR ELEVATION

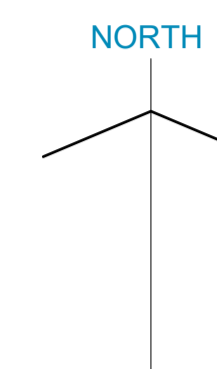


PROPOSED FRONT ELEVATION




PROPOSED LOCATION PLAN - SCALE 1:1250





PROPOSED SITE PLAN - SCALE 1:500

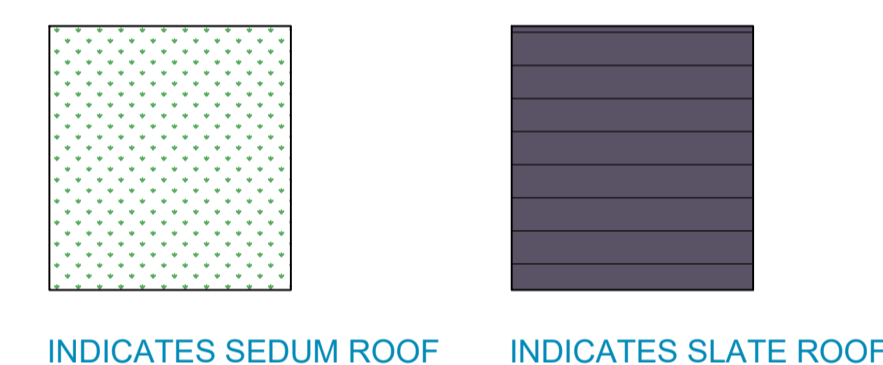


INDICATES SEDUM ROOF INDICATES SLATE ROOF

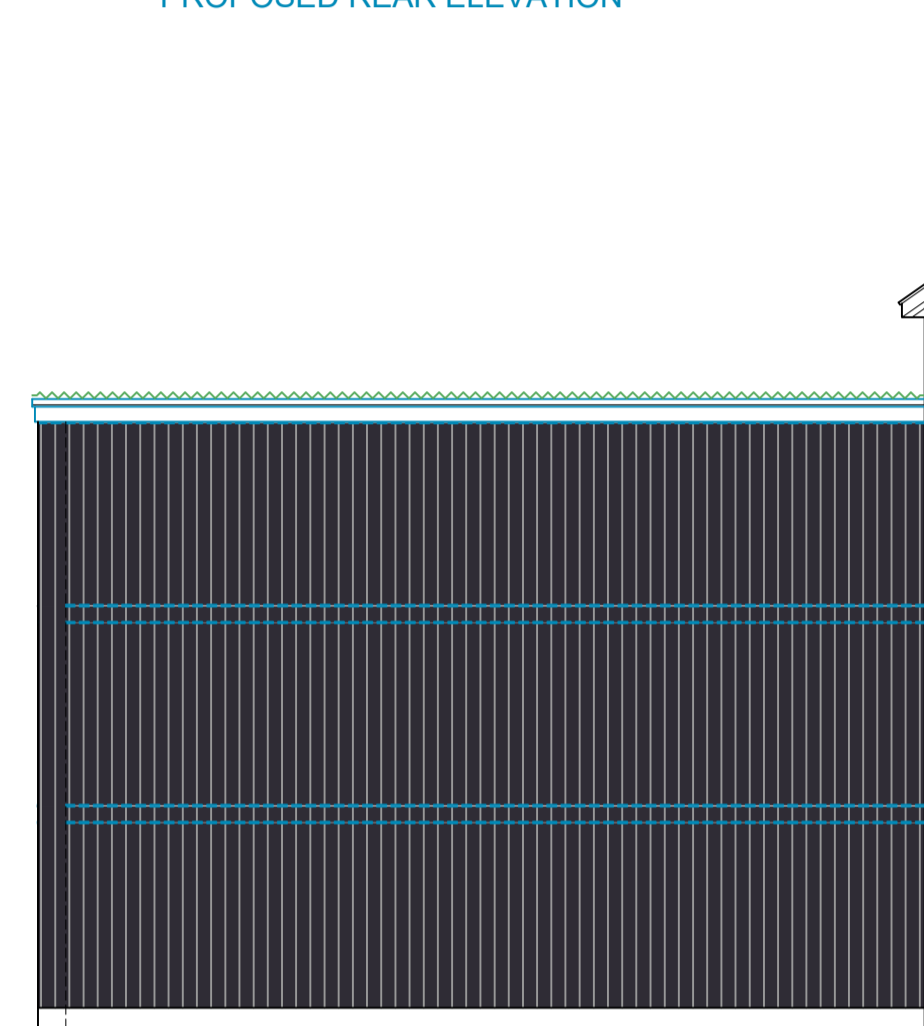


PROPOSED SIDE ELEVATION

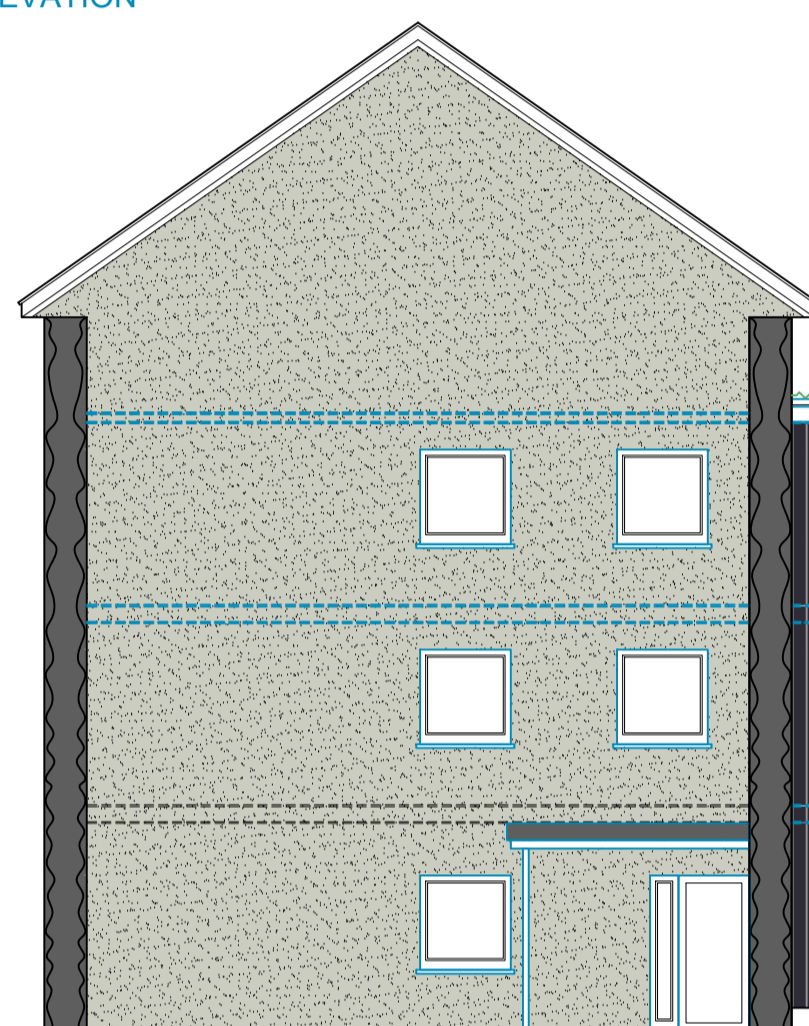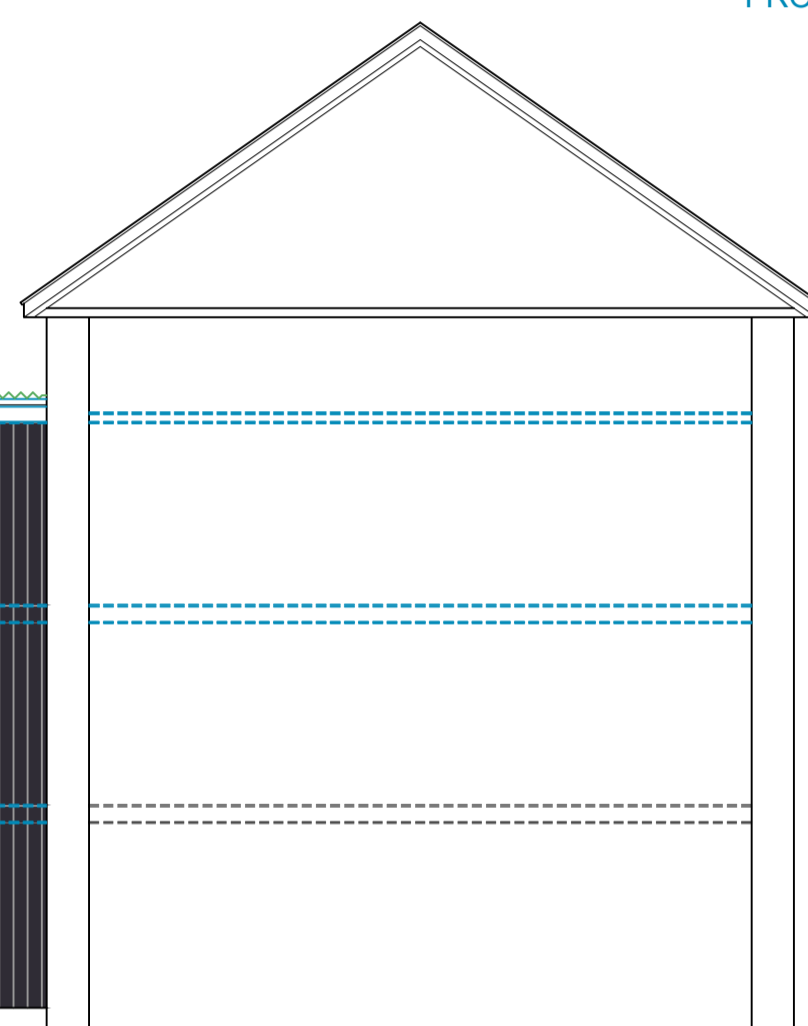


PROPOSED SIDE ELEVATION MAIN ENTRANCE

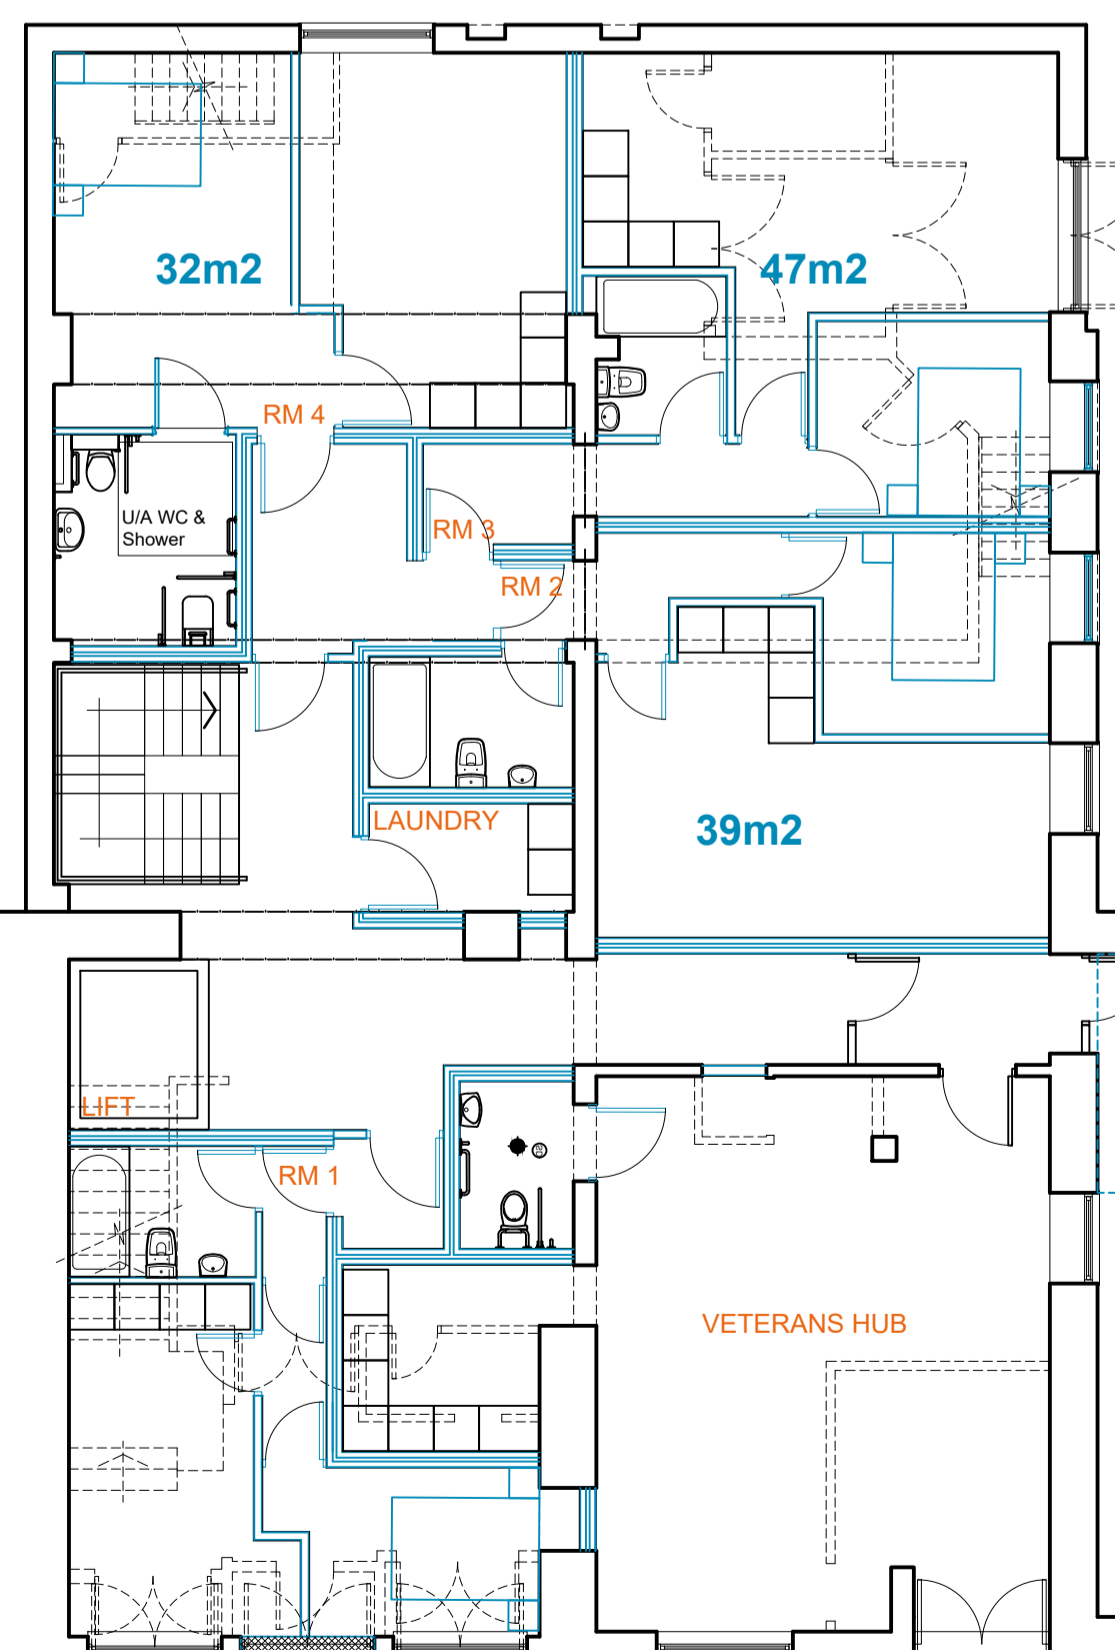


PROPOSED GROUND FLOOR
SCALE - 1:100
0 1.0 2.0 3.0 4.0 5.0 6.0 7.0 8.0 9.0 10.0 [m]

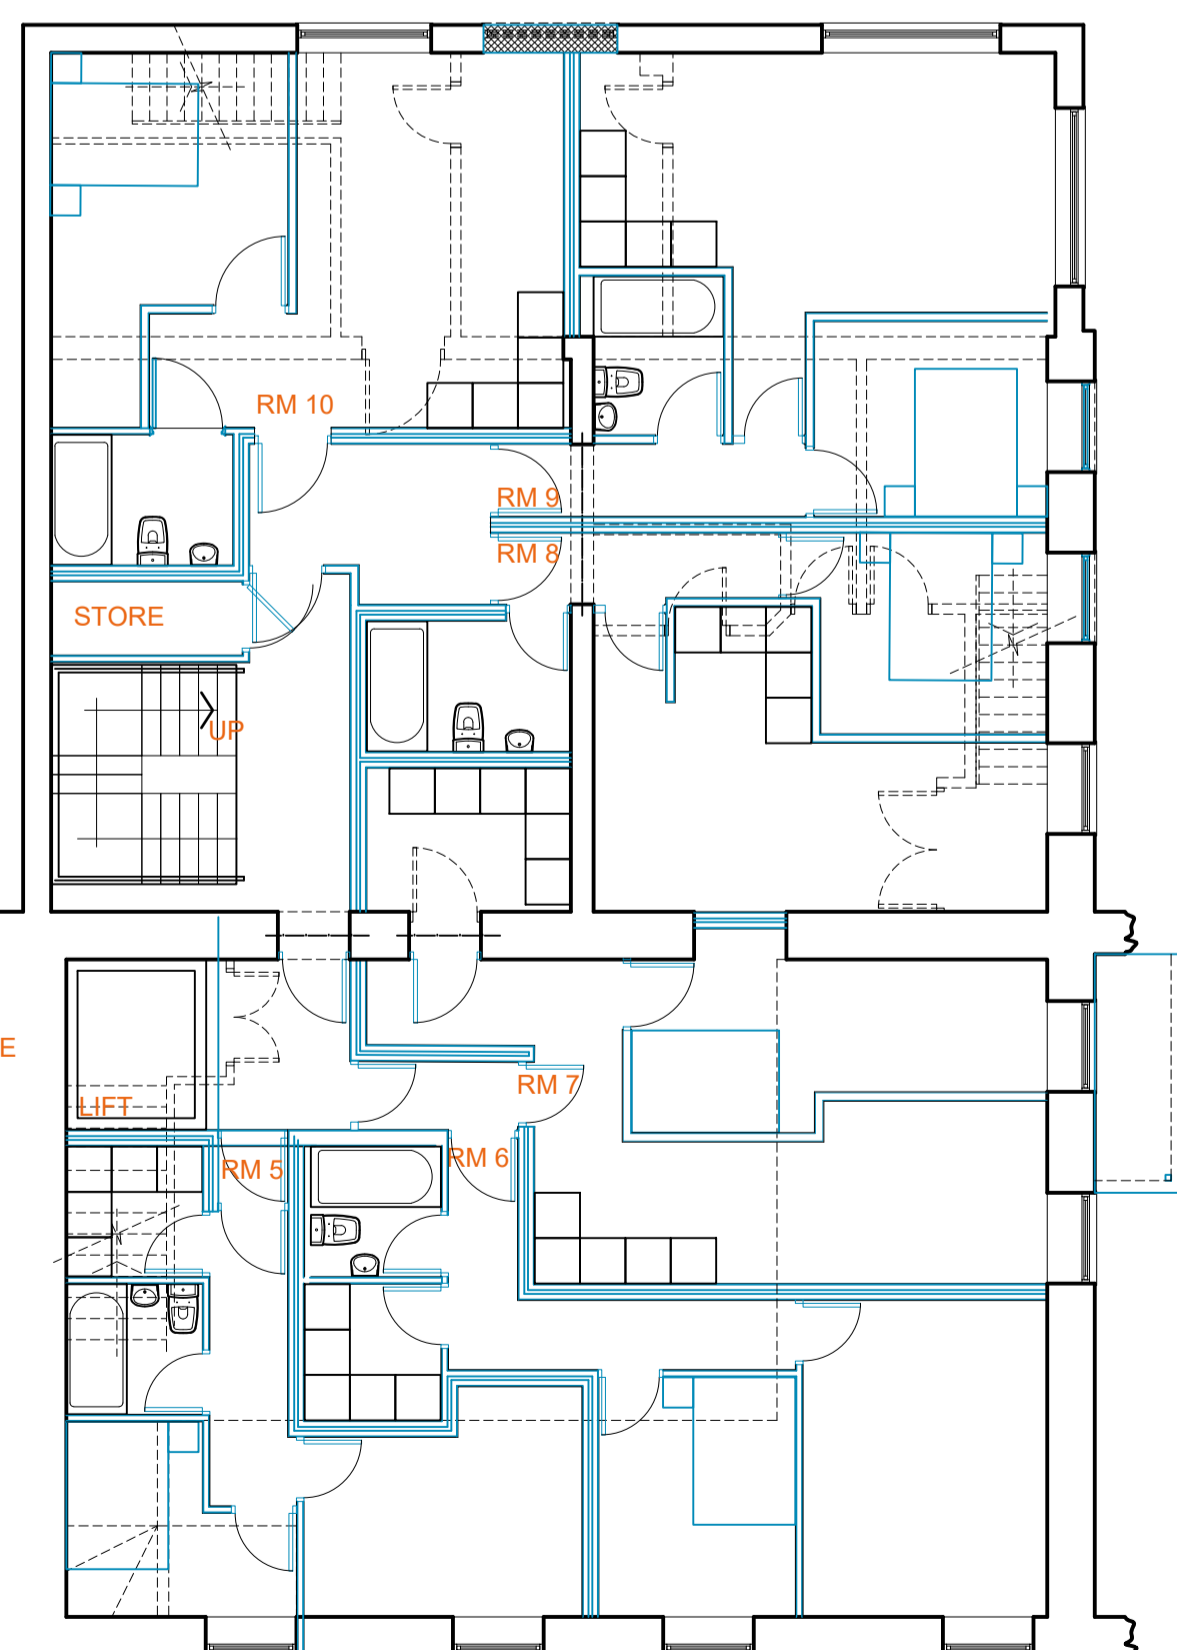

PROPOSED FIRST FLOOR
SCALE - 1:500
0 5 10 15 20 25 30 35 40 45 50 55 60 65 70 75 80 85 90 95 100 [m]

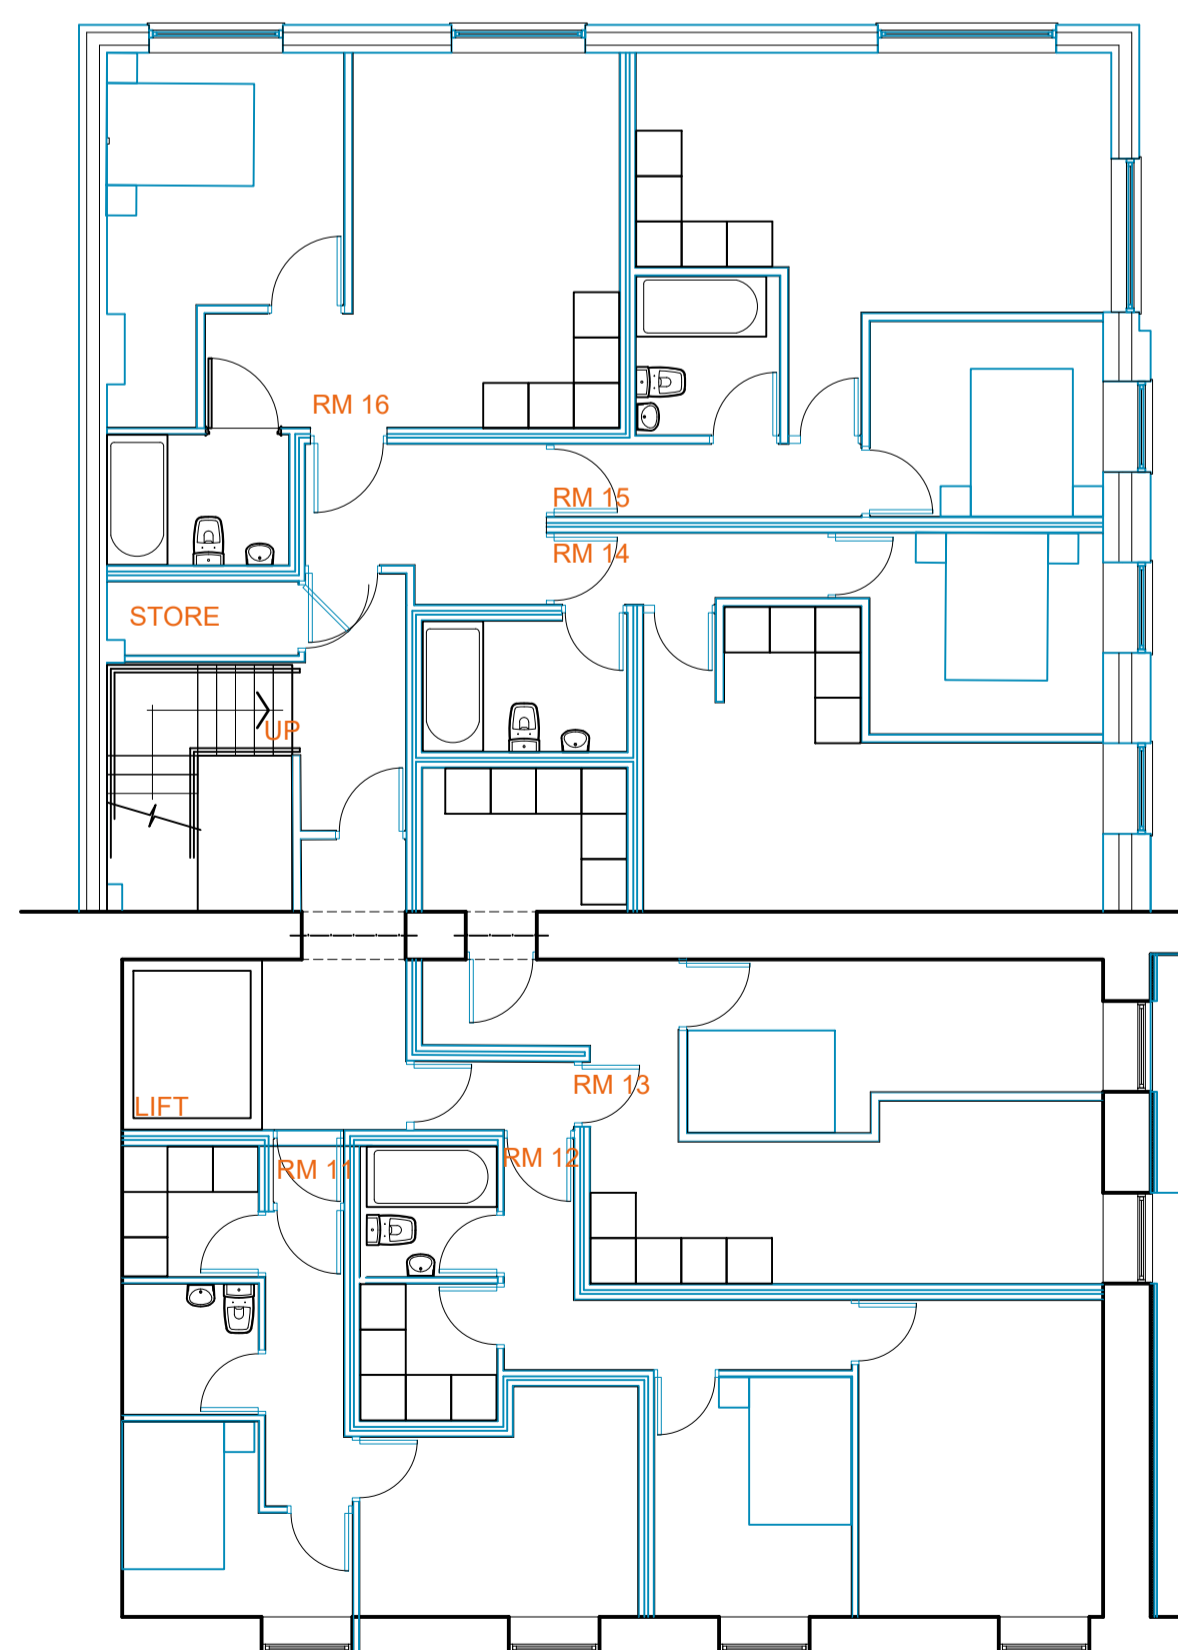

PROPOSED SECOND FLOOR
SCALE - 1:1250
0 20 40 60 80 100 [m]

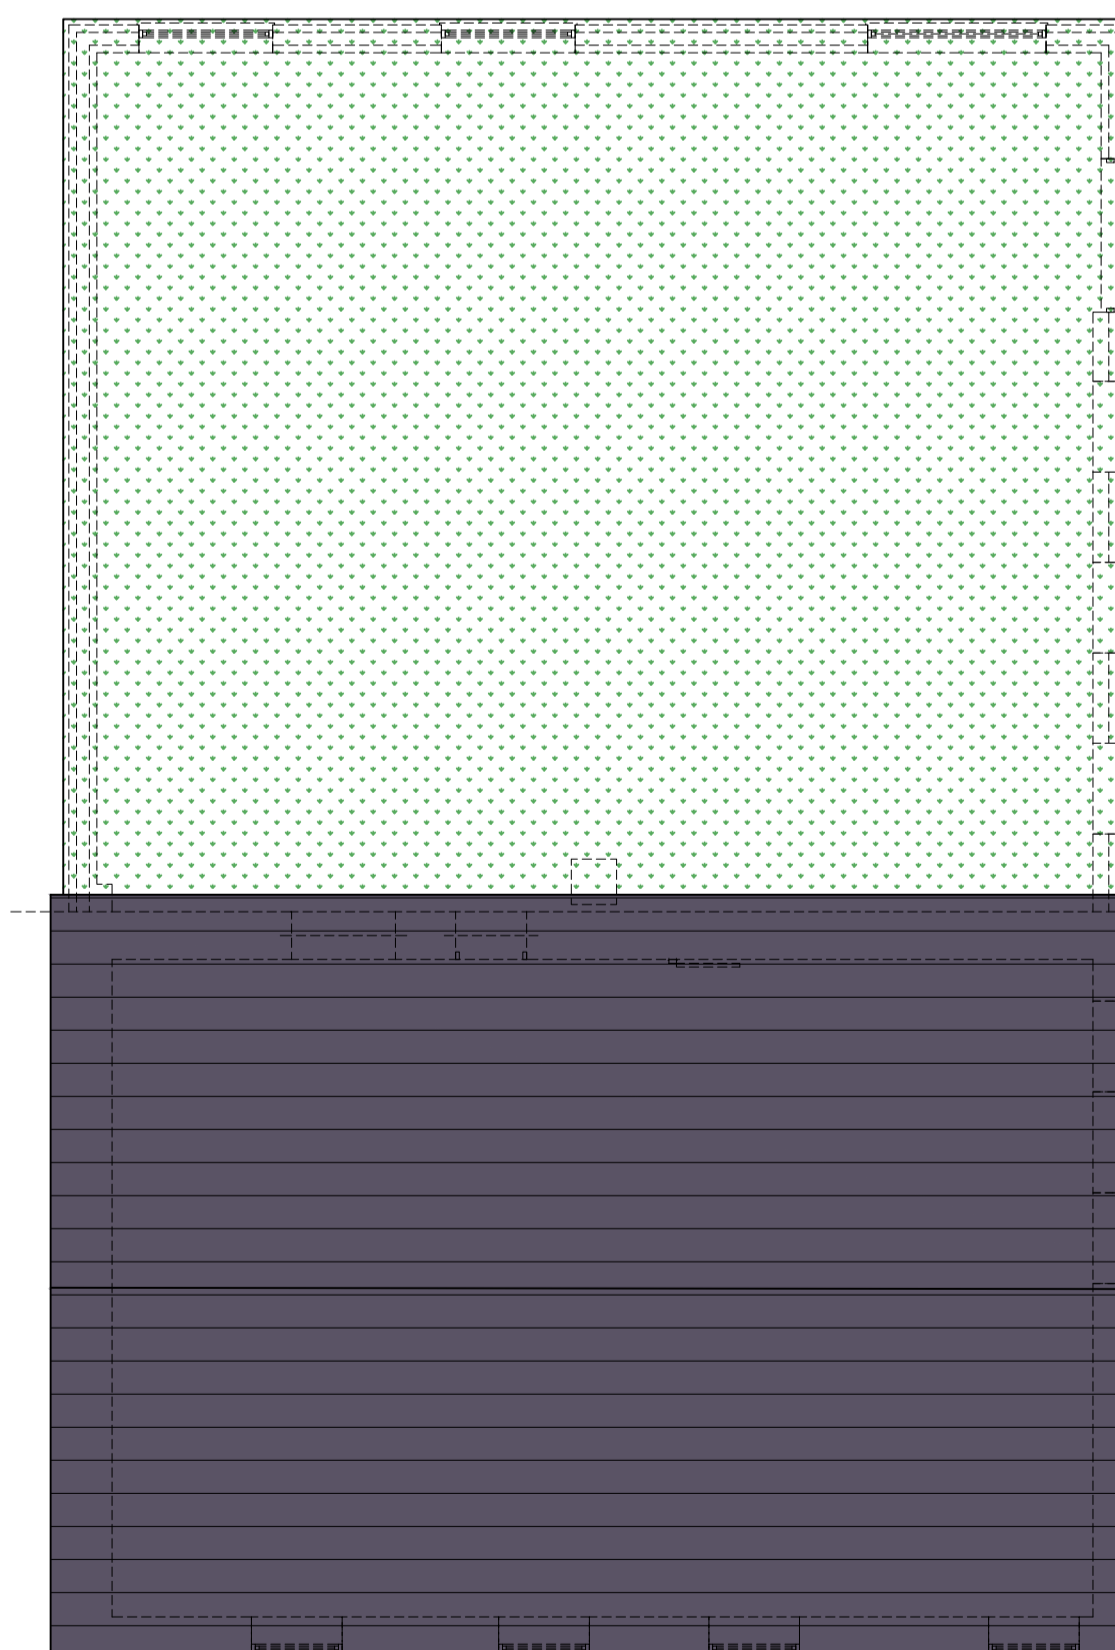

PROPOSED ROOF



Site
HHVUK
33-35 MURRAY STREET, LLANELLI, DYFED

Title
**PLANNING DRAWING
PROPOSED SCHEME**

Project Manager/ Checked	Drawn By TH	Scale 1:100	Date 12/2024
Arch./Des.	Drawing Number 24:153 - 002		Rev.